
# Appendix A Design Drawings

# V-TANK REMEDIATION PROJECT IDAHO FALLS, IDAHO

#### **DRAWING INDEX**

## FINAL DESIGN

SITE VICINITY MAP

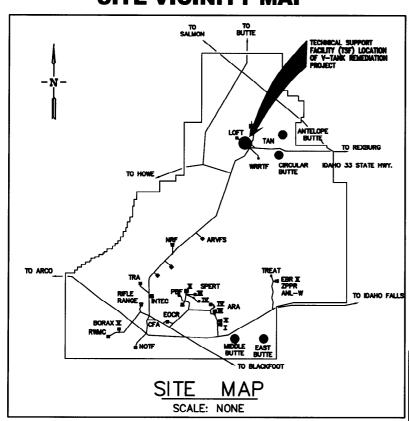

PREPARED FOR: BECHTEL BWXT IDAHO, LLC

SUBCONTRACT #K01-564442 NOVEMBER 16, 2001



Revisions								Date	
Rev. No.:	Date:	Descriptions:	Drawn By:	Checked By:	Project A/E:	Approval:	Designed by:	R. Ederer	11/16/01
			-				Drawn by:	JMM/KDF	11/16/01
-							Checked by:	D.Brennecke	11/16/01
							Project Manager:	B. Keehian	11/16/01
-			-			ļ	Client Approval:		
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DRAWING NUMBER

TITLE

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General Notes, Symbols,		
and AbbreviationsABQ	00002-R00-T02	Sheet 2 of 20
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Grading & Surface Demolition PlanABQ	00011-R00-C02	Sheet 4 of 20
Access Control & Site Layout PlanABQ	00004-R00-C03	Sheet 5 of 20
Access Control Building PlanABQ		Sheet 6 of 20
Pipe Removal PlanABQ	00005-R00-C05	Sheet 7 of 20
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Removal PlanABQ	00006-R00-C06	Sheet 8 of 20
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Site Restoration PlanABO	00009-R00-C17	
Miscellaneous DetailsABQ	00010-R00-C18	Sheet 20 of 20
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WESTON

6501 AMERICAS PARKWAY SUITE 800 ALBUQUERQUE, NM 87111 (505) 884-5050 V-TANK REMEDIATION PROJECT IDAHO FALLS, IDAHO

TITLE SHEET

DRAWTING NO.: ABQ 00001-R00-T01 SHEET # 1 OF

BQ00001\_R00\_T01.DWG.KDF 11-16-0

## LINETYPE LEGEND

### PLAN VIEW

#### DRAWING LEGEND

SECTION

TOPSOIL

CONCRETE

WATER LEVEL

TRENCH SHIELD

**50.68** 

246

\$ . A

COMMON BORROW

UNDISTURBED SOIL

AGGREGATE BASE

GRAVEL OR DRAIN ROCK

#### **ABBREVIATIONS**

EXISTING ELECTRICAL/TELEPHONE/CABLE TELEVISION/UNKNOWN (BURIED) -E-T-CTV- ?-SANITARY SEWER/DRAIN/ WATER/IRRIGATION WATER/GAS (BURIED) >--- NEW CULVERT EXISTING CULVERT OVERHEAD ELECTRIC/TELEPHONE 4' HIGH ACCESS CONTROL FENCE TEMPORARY 6' CHAIN LINK ACCESS DRAINAGE DITCH EDGE OF EXISTING ASPHALT GRADE BREAK LINES ACCESS ROUTE LINE ////// PIPING TO BE REMOVED 

UTILITY POLE SURVEY COORDINATE SLOPE/FLOW ARROW TOP OF SLOPE SURVEY CONTROL POINT FIRE HYDRANT EXISTING CONCRETE

NEW GRAVEL SURFACE

Rev. No.: Date:

DIVANIL	O LLOLIND
5210	EXISTING CONTOUR
`	INTERMEDIATE CONTOUR
	PROPOSED CONTOUR
+	SPOT ELEVATIONS
	BUILDING/STRUCTURE
	V-DITCH

AOC	AREA OF CONTAMINATION	NA	NOT APPLICABLE
<b>E</b>	CENTER LINE	NIC	NOT IN CONTRACT
CONC.	CONCRETE	NTS	NOT TO SCALE
CMP	CORRUGATED METAL PIPE	ос	ON CENTER
D&D	DEMOLITION & DECONDITIONING	<b>የ</b>	PROPERTY LINE
DIA. OR #	DIAMETER	PP	POWER POLE
E	EASTING	PVC	POLYVINYL CHLORIDE
ELEC	ELECTRIC	SAN	SANITARY SEWER
ELEV	ELEVATION	SHT.	SHEET
EXIST	EXISTING	SSD	SANITARY SEWER-CONCRETE
FL	FLOW LINE	SF	SQUARE FEET
HASP	HEALTH & SAFETY PLAN	TYP	TYPICAL
HDA	HOT DRAIN-STAINLESS STEEL	UG	UNDERGROUND
HDPE	HIGH DENSITY POLYETHYLENE	UST	UNDERGROUND STORAGE TANK
HIC	HIGH INTEGRITY CONTAINER	vco	VOLUNTARY CONSENT ORDER
INV	INVERT	voc	VOLATILE ORGANIC COMPOUNDS
IW	IRRIGATION WATER	w	WATER
LF.	LINEAR FOOT	WAC	WASTE ACCEPTANCE CRITERIA
MH	MANHOLE	WDA	WARM DRAIN-STAINLESS STEEL

#### **GENERAL NOTES**

- · - ROOF LINES

- TAN TANK V-TANK AREA TOPOGRAPHIC SURVEY SURVEYED BY SUTHERLIN & GRADY. DATUM: NAD-27 STATE PLANE AND 1929 VERTICAL. SURVEY DATE: 04/19/01.
- THE FOLLOWING IS THE LIST DRAWINGS PROVIDED BY INEEL AND USED BY WESTON TO IDENTIFY AND LOCATE UTILITIES SHOWN ON THESE CONSTRUCTION DRAWINGS.

nie	INFEL DRAWING NO.	DATE
TAN RADIOACTIVE LIQUID WASTE UNDERGROUND PIPING 807 AREA	422643	3-88
TAN/TSF AREA FIRE WATER & UTILITY WATER SITE PLAN	423185	12-15-88
TAN RADIOACTIVE LIQUID WASTE UNDERGROUND PIPING PLAN	422642	3–88
TFS AREA WASTE LINE IDENTIFICATION	154298	11-15-71
ANP LIQUID WASTE TREATMENT PLANT BLDG. 616, PLANS, ELEVATIONS SECTIONS & DETAILS	106889	12-20-52
ANP ASSEMBLY & MAINTENANCE AREA LIQUID WASTE TREATMENT PLANT 616 PIPING PLAN	106892	12-20-52
ANP ASSEMBLY & MAINTENANCE AREA LIQUID WASTE TREATMENT PLANT 616 VESSEL DETAILS & ORIENTATIONS	106894	12-20-52
ANP ASSEMBLY & MAINTENANCE AREA LIQUID WASTE TREATMENT PLANT 618 PIPING SECTIONS	106893	12-20-52
TAN RADIOACTIVE LIQUID WASTE STORAGE AND TRANSFER SYSTEM	138651	11-3-82

- ALL ACTIVE UNDERGROUND PIPING AND UTILITIES SHALL BE LOCATED AND DE-ENERGIZED PRIOR TO CONSTRUCTION BY ELECTRONIC LOCATING DEVICES OR EXPLORATORY EXCAVATIONS.
- STORM WATER CONTROLS SHALL BE IN PLACE PRIOR TO START OF EXCAVATION WORK.

	A	—DE
	23	—SI- DE
SHEET(S) FROM WHICH DETAIL/SECTION HAS BEEN TAKEN ——		

Drawn By: Checked By: Project A/E: Approval:

Revisions

Descriptions:

## SECTION AND DETAIL SYMBOL

DETAIL NUMBER/SECTION LETTER SHEET ON WHICH DETAIL/SECTION IS DRAWN

R. Ederer

JMM/KDF

Project Manager: B. Keehion 11/16/01

D.Brennecke 11/16/01

11/16/01

11/16/01

#### LINE IDENTIFICATION

HD - HOT DRAIN WD - WARM DRAIN

SW - SERVICE WASTE (COLD DRAIN)

SS - SANITARY SEWER

WDC

ERED PROP

MINIMUM

METAL

MONITORING WELL

V-TANK REMEDIATION PROJECT IDAHO FALLS, IDAHO

**GENERAL NOTES.** SYMBOLS, AND ABBREVIATIONS

WARM DRAIN-CAST IRON

WATER LEVEL

NORTHING

DRAWING NO.: ABQ 00002-R00-T02


BQ00002\_R00\_T02.DWG.KDF 11-16-01


2 of 20 PROJECT NO.: 12393,002,001


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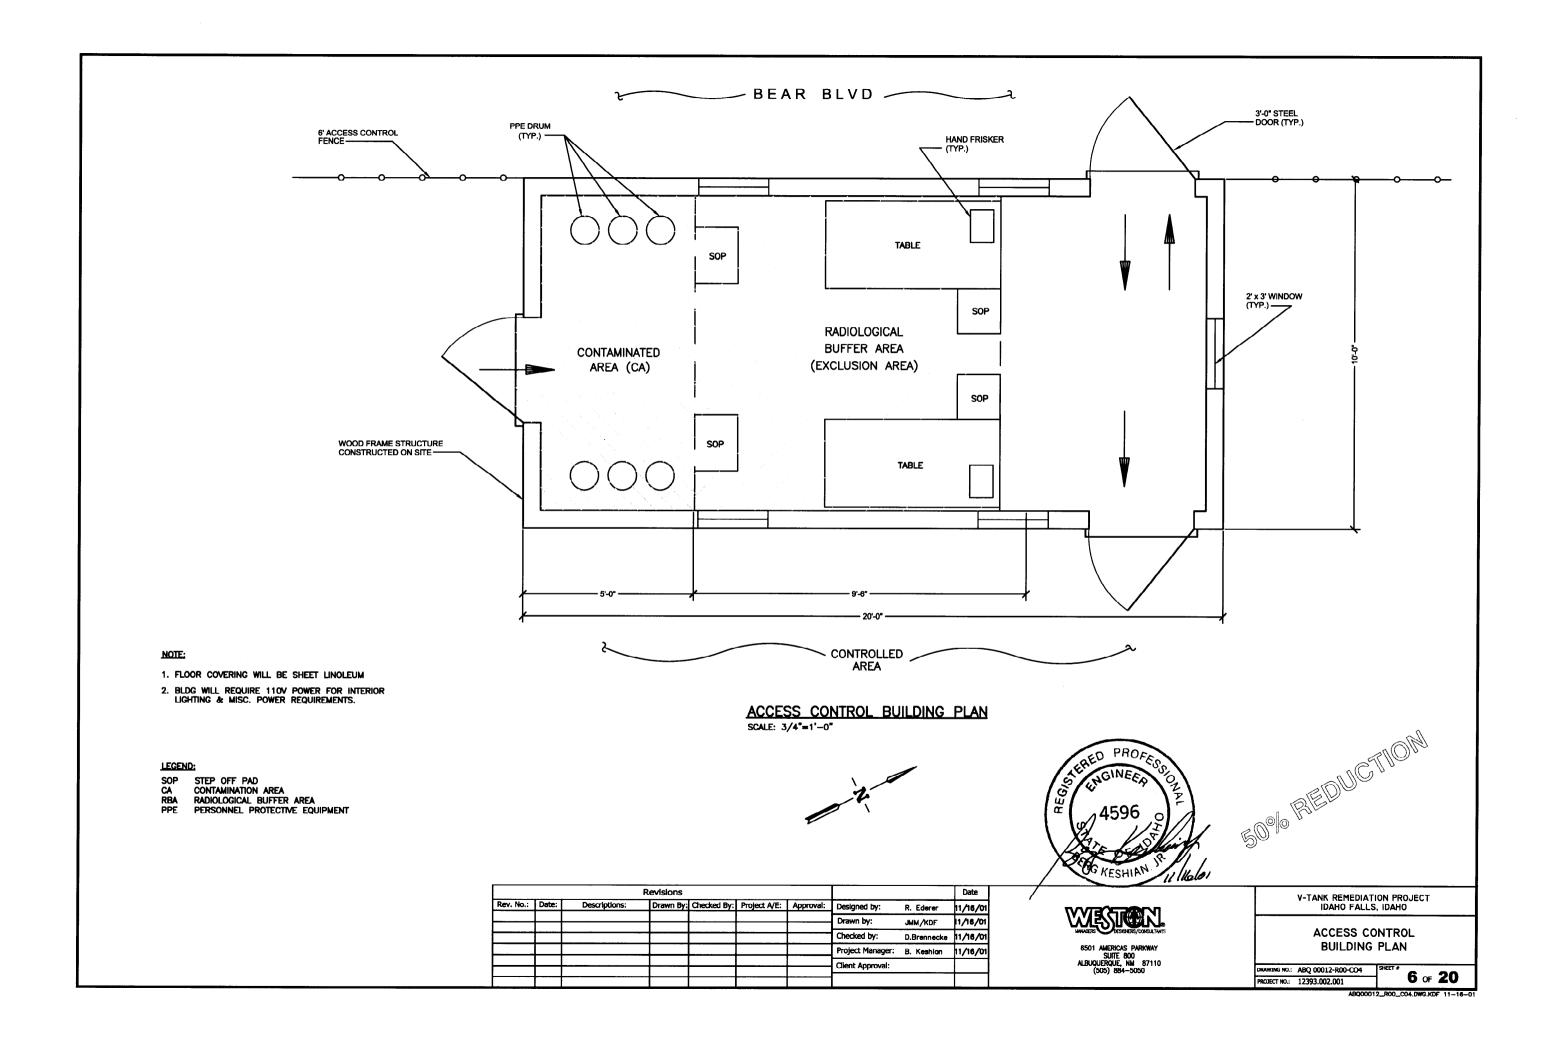
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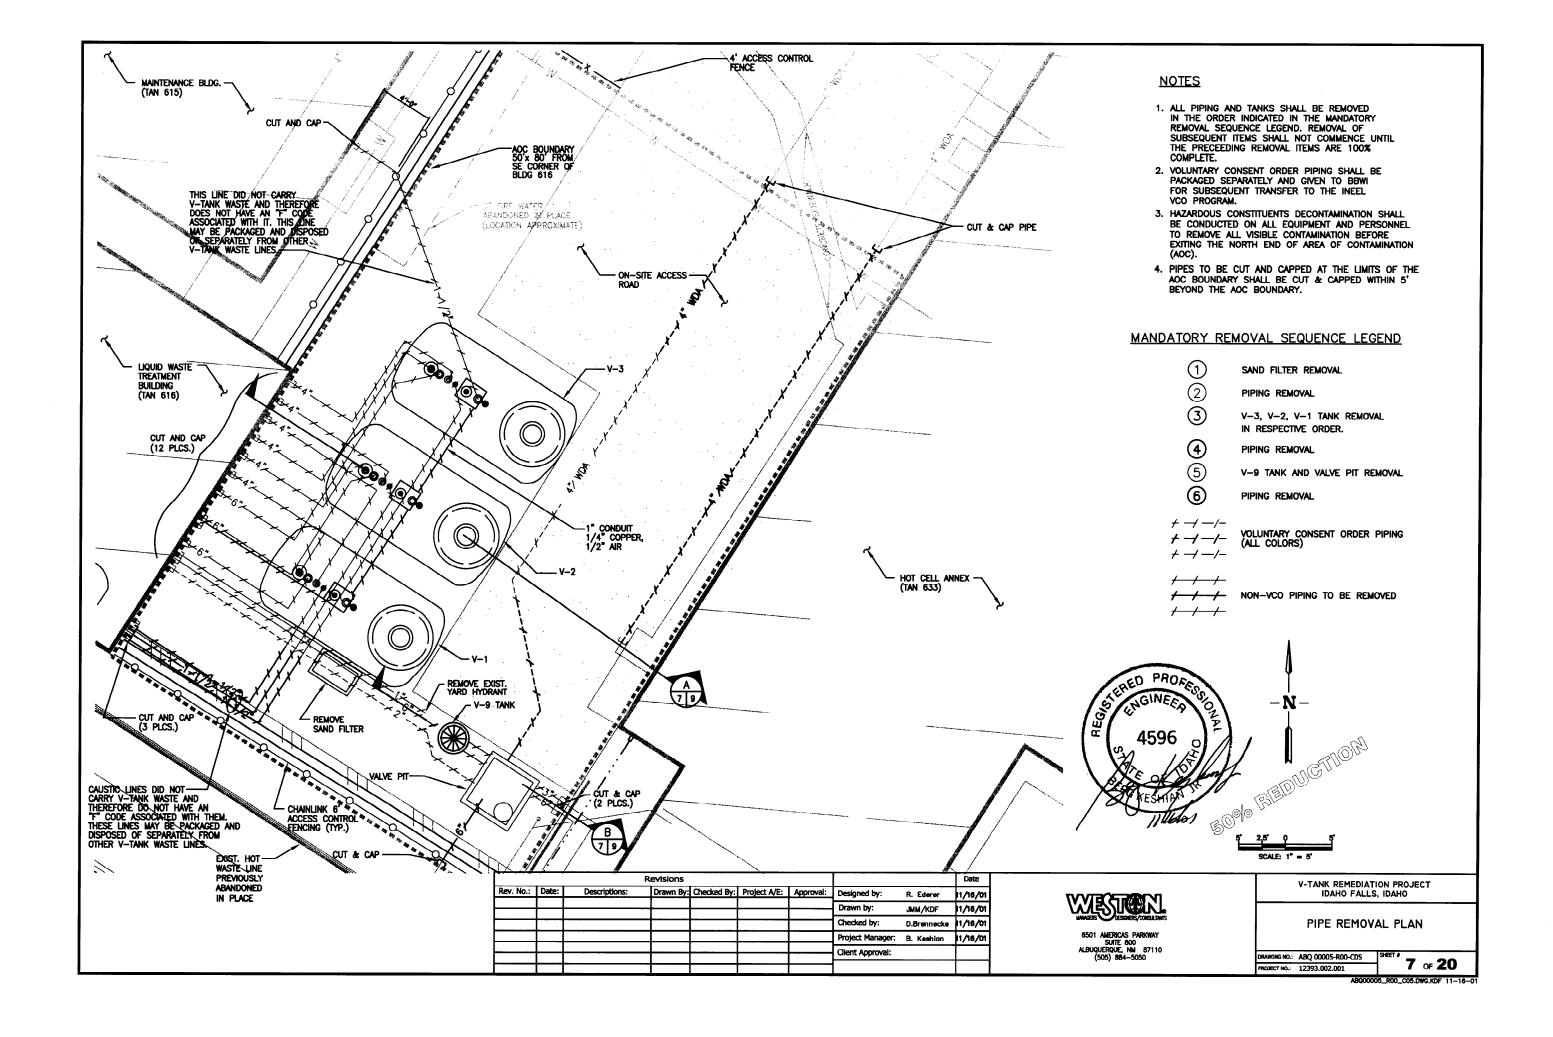
Client Approval:







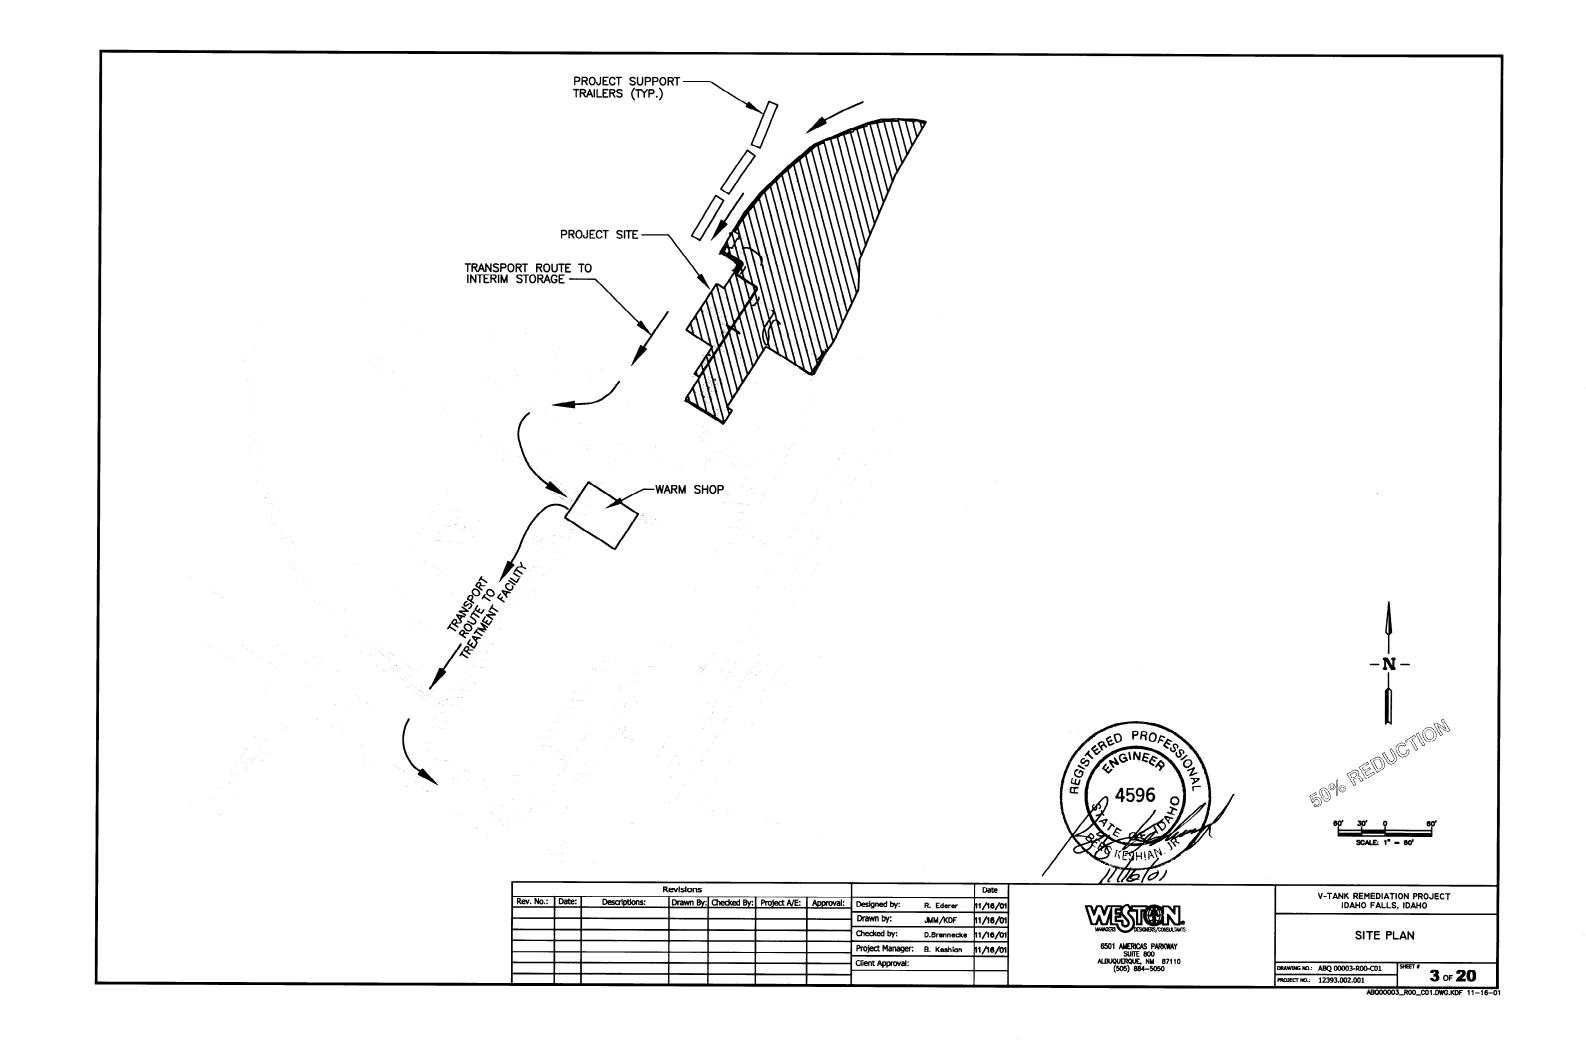


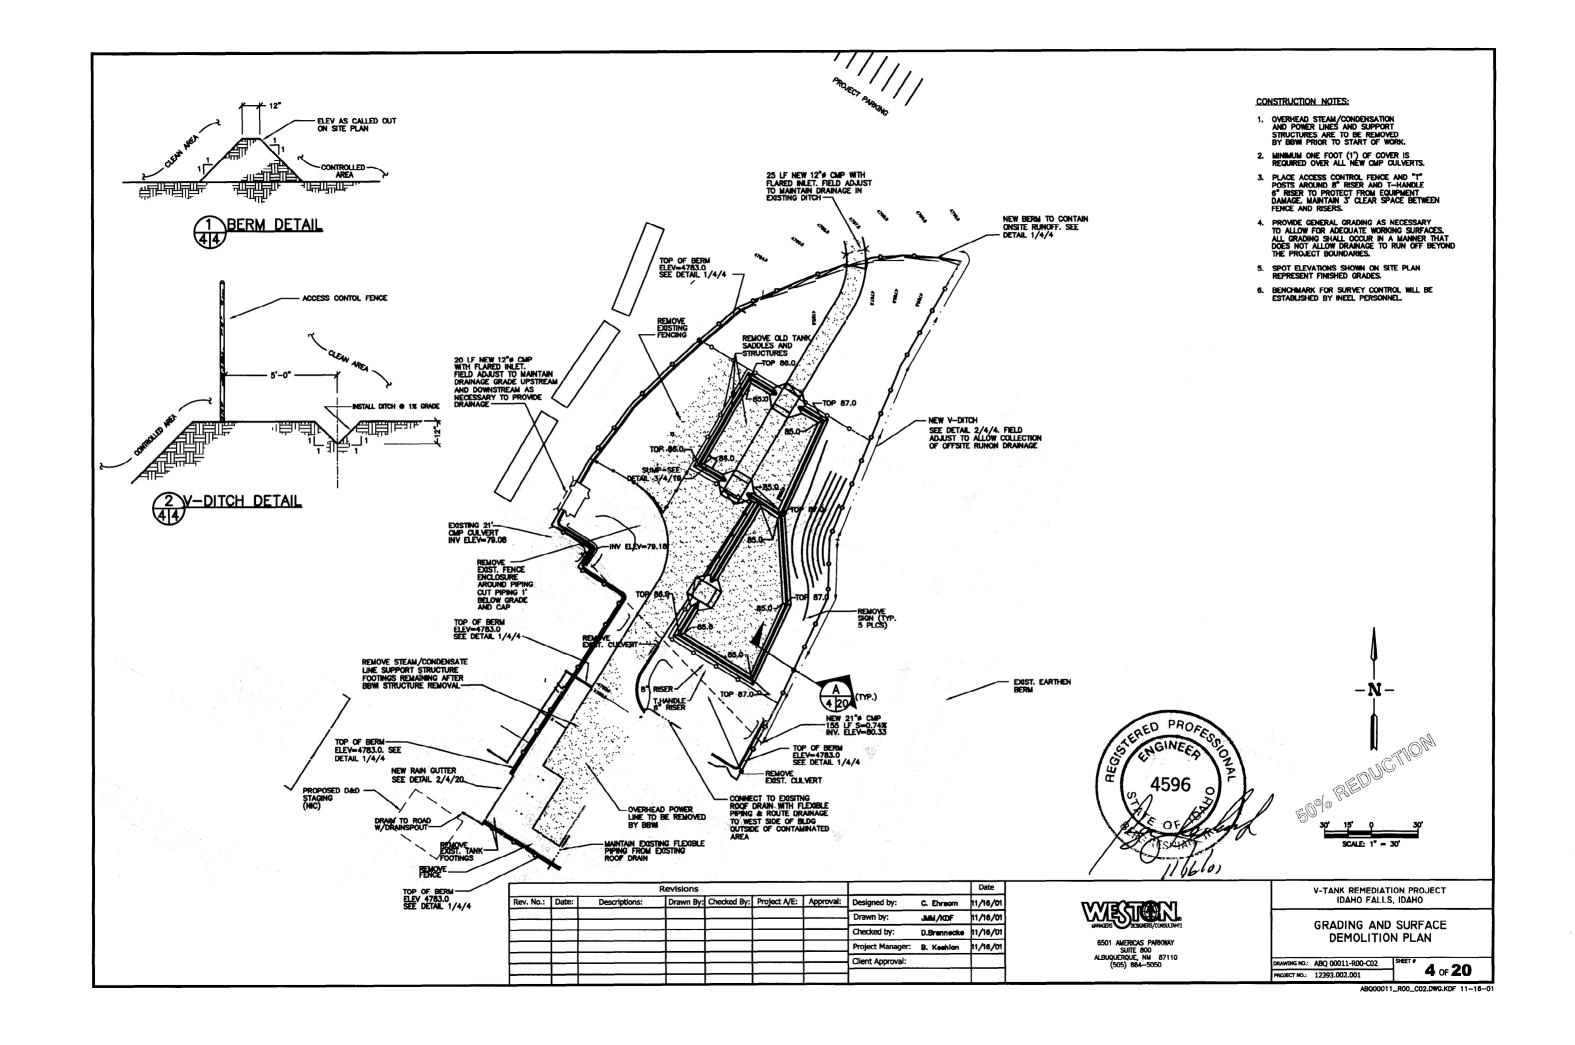

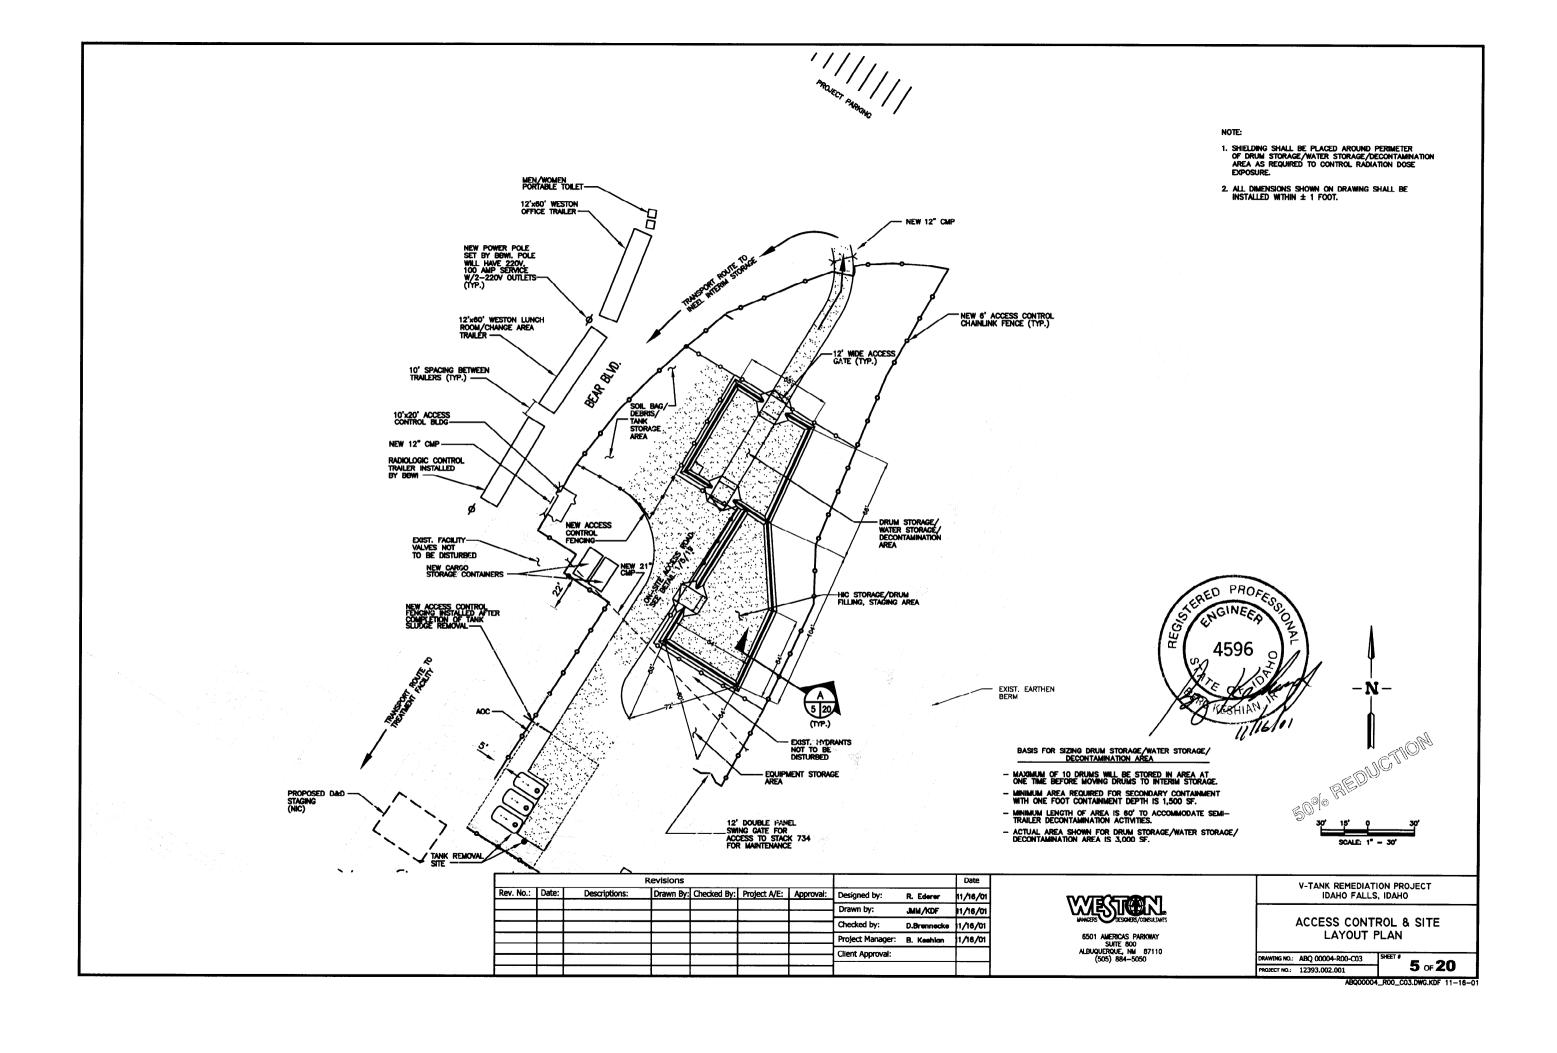

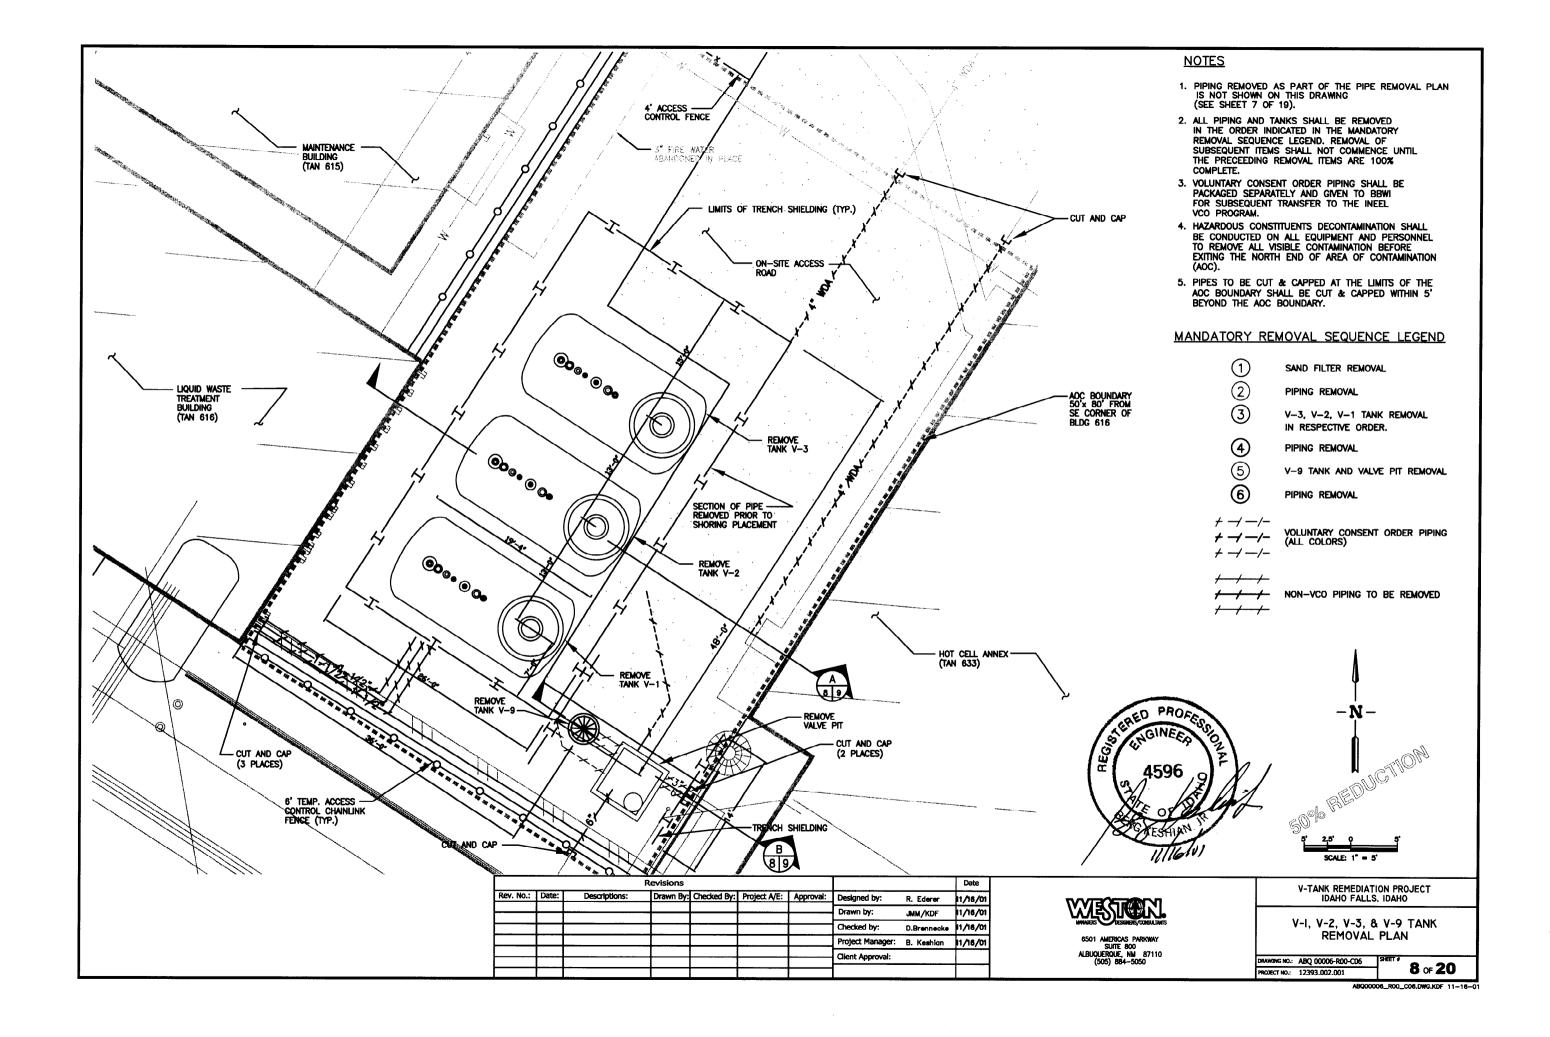

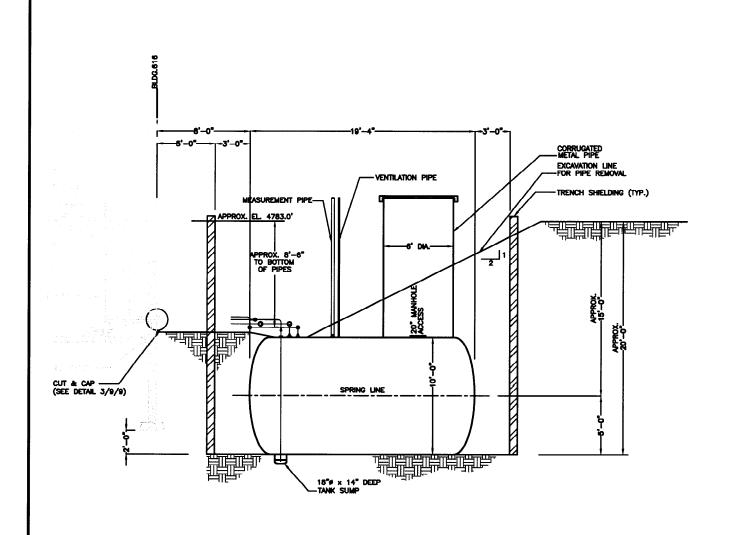

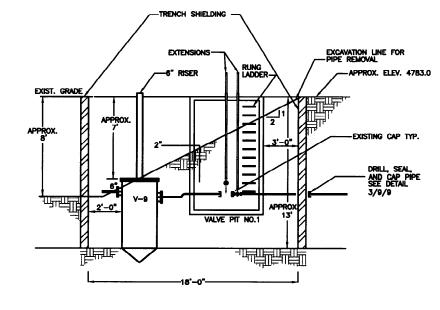



B TANK V-9 EXCAVATION SECTION SCALE: 1/4"=1'-0"

1. WILVE PIT AND PIPING WITHIN WALVE PIT ARE PART OF A VOO PROGRAM. SEE SHEET 7/19 FOR PIPING OUTSIDE OF WALVE PIT. WALVE PIT & PIPILINE SHALL BE REMOVED, PACKAGED, AND DELIVERED TO THE INEEL VCO PROGRAM.



- DIMENSIONS OF EXISTING STRUCTURES, PIPING, AND TANK ARE APPROXIMATE.
  THESE FEATURES SHALL BE VERIFIED BY EXPLORATORY EXCAVATION. LOCKOUT AND
  TAG ALL ISOLATION VALVES.
- 2. PIPING AND TANKS ARE ASSUMED TO BE STAINLESS STEEL. BASED ON AVAILABLE AS—BUILT INFORMATION
- 3. VERIFY ELECTICAL SUPPLY LOCATION. LOCKOUT AND TAG. PER SITE HASP.
- 4. ALL PIPE WILL BE EXPOSED AND CUT TO APPROPRIATE LENGTHS.
- DEPTH OF BUILDING 616 FOOTING IS ESTIMATED, IF EXCAVATION IS REQUIRED OUTSIDE OF TRENCH SHIELDING AND ADJACENT TO BLDG 616, ACTUAL DEPTH OF FOOTING SHALL BE FIELD VERIFIED.

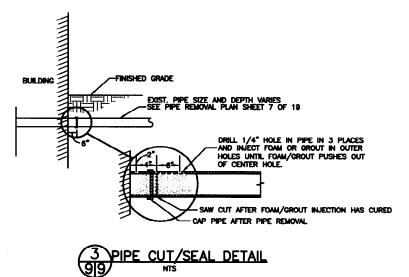

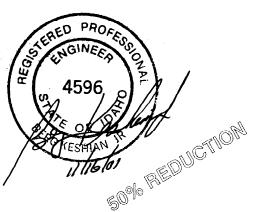

Revisions								Date	
Rev. No.:	Date:	Descriptions:	Drawn By:	Checked By:	Project A/E:	Approval:	Designed by:	R. Ederer	11/16/01
							Drawn by:	JMM/KDF	11/16/01
			_				Checked by:	D.Brennecke	11/16/01
							Project Manager:	B. Keshian	11/16/01
							Client Approval:		-
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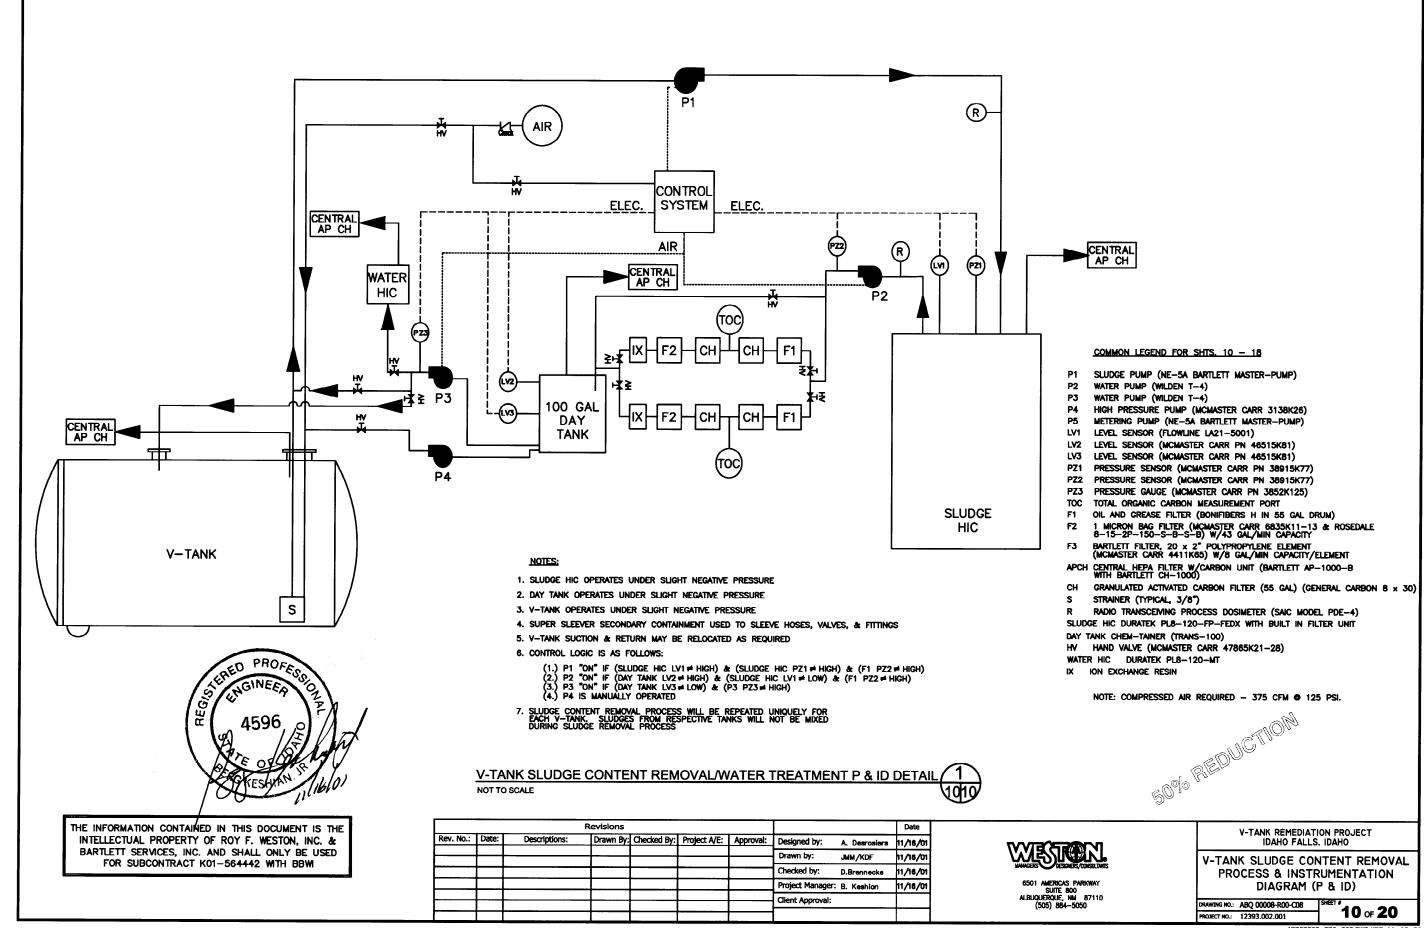
SUITE 800 ALBUQUERQUE, NM 87110 (505) 884-5050


V-TANK REMEDIATION PROJECT IDAHO FALLS, IDAHO

**DEMOLITION & EXCAVATION** DETAILS

DRAWING NO.: ABQ 00007-R00-C07
PROJECT NO.: 12393.002.001

9 of 20



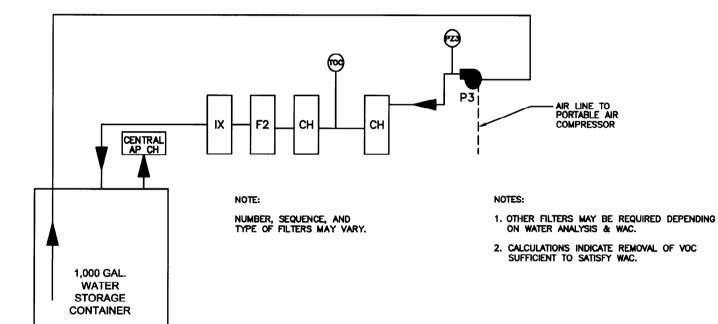

V-TANK BACKUP WATER TREATMENT P & ID DETAIL

#### COMMON LEGEND FOR SHTS. 10 - 18

SLUDGE PUMP (NE-5A BARTLETT MASTER-PUMP)

P2 WATER PUMP (WILDEN T-4)

WATER PUMP (WILDEN T-4)

HIGH PRESSURE PUMP (MCMASTER CARR 3138K26) P4

P5 METERING PUMP (NE-5A BARTLETT MASTER-PUMP)

LV1 LEVEL SENSOR (FLOWLINE LA21-5001) LV2 LEVEL SENSOR (MCMASTER CARR PN 46515K81)

LEVEL SENSOR (MCMASTER CARR PN 46515K81)

PZ1 PRESSURE SENSOR (MCMASTER CARR PN 38915K77)

PZ2 PRESSURE SENSOR (MCMASTER CARR PN 38915K77)

PZ3 PRESSURE GAUGE (MCMASTER CARR PN 3852K125)

TOC TOC MEASUREMENT PORT

F1 OIL AND GREASE FILTER (BONIFIBERS H IN 55 GAL DRUM)

1 MICRON BAG FILTER (MCMASTER CARR 6835K11-13 & ROSEDALE 8-15-2P-150-S-B-S-B) W/43 GAL/MIN CAPACITY F2

BARTLETT FILTER, 20 x 2" POLYPROPYLENE ELEMENT (MCMASTER CARR 4411K65) W/8 GAL/MIN CAPACITY/ELEMENT

APCH CENTRAL HEPA FILTER W/CARBON UNIT (BARTLETT AP-1000-B WITH BARTLETT CH-1000)

GRANULATED ACTIVATED CARBON FILTER (55 GAL) (GENERAL CARBON 8 x 30) STRAINER (TYPICAL, 3/8")

RADIO TRANSCEIMING PROCESS DOSIMETER (SAIC MODEL PDE-4) SLUDGE HIC DURATEK PL8-120-FP-FEDX WITH BUILT IN FILTER UNIT

DAY TANK CHEM-TAINER (TRANS-100)

HV HAND VALVE (MCMASTER CARR 47865K21-28)

WATER HIC DURATEK PL8-120-MT

IX ION EXCHANGE RESIN

NOTE: COMPRESSED AIR REQUIRED - 375 CFM • 125 PSI.

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TERED PROFE 11/16/01

Revisions Date Descriptions: Drawn By: Checked By: Project A/E: Approval: Designed by: A. Desrosiers 11/16/01 Drawn by: AL/JMM 11/16/01 Checked by: D.Brennecke 11/16/01 Project Manager: B. Keshion 11/16/01

Client Approval:




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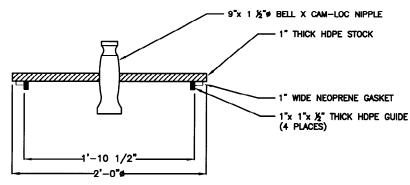
V-TANK REMEDIATION PROJECT IDAHO FALLS, IDAHO

V-TANK WATER TREATMENT PROCESS & INSTRUMENTATION (P & ID) DETAILS

DRAWING NO.: ABQ 00013-R00-C09 SHEET PROJECT NO.: 12393,002,001

**11** ₀ **20** 



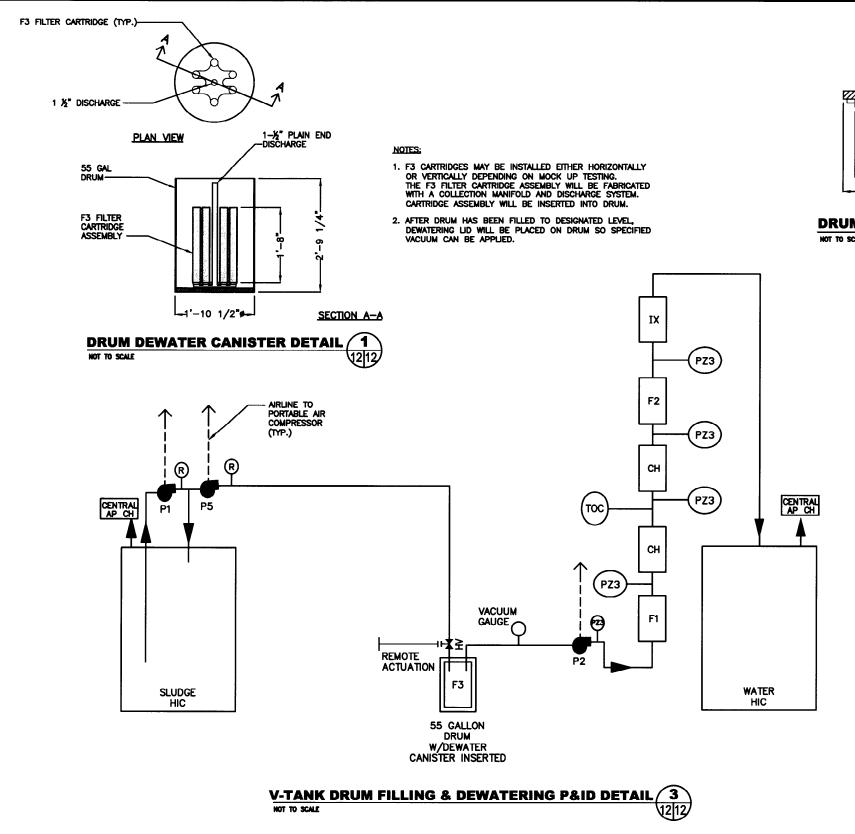

DRUM DEWATERING LID DETAIL 2 NOT TO SCALE

#### COMMON LEGEND FOR SHTS. 10 - 18

- SLUDGE PUMP (NE-5A BARTLETT MASTER-PUMP)
- P2 WATER PUMP (WILDEN T-4)
- WATER PUMP (WILDEN T-4)
- HIGH PRESSURE PUMP (MCMASTER CARR 3138K26)
- METERING PUMP (NE-5A BARTLETT MASTER-PUMP)
- LV1 LEVEL SENSOR (FLOWLINE LA21-5001)
- LV2 LEVEL SENSOR (MCMASTER CARR PN 46515K81)
- LV3 LEVEL SENSOR (MCMASTER CARR PN 48515K81)
- PZ1 PRESSURE SENSOR (MCMASTER CARR PN 38915K77)
- PZ2 PRESSURE SENSOR (MCMASTER CARR PN 38915K77)
- PZ3 PRESSURE GAUGE (MCMASTER CARR PN 3852K125)
- TOC TOC MEASUREMENT PORT
- F1 OIL AND GREASE FILTER (BONIFIBERS H IN 55 GAL DRUM)
- 1 MICRON BAG FILTER (MCMASTER CARR 6835K11-13 & ROSEDALE 8-15-2P-150-S-B-S-B) W/43 GAL/MIN CAPACITY
- BARTLETT FILTER, 20 x 2" POLYPROPYLENE ELEMENT (MCMASTER CARR 4411K65) W/8 GAL/MIN CAPACITY/ELEMENT
- APCH CENTRAL HEPA FILTER W/CARBON UNIT (BARTLETT AP-1000-B WITH BARTLETT CH-1000)
- GRANULATED ACTIVATED CARBON FILTER (55 GAL) (GENERAL CARBON 8 x 30)
- STRAINER (TYPICAL, 3/8")
- RADIO TRANSCEIVING PROCESS DOSIMETER (SAIC MODEL PDE-4)
- SLUDGE HIC DURATEK PL8-120-FP-FEDX WITH BUILT IN FILTER UNIT
- DAY TANK CHEM-TAINER (TRANS-100)
- HV HAND VALVE (MCMASTER CARR 47865K21-28)
- WATER HIC DURATEK PL8-120-MT
- IX ION EXCHANGE RESIN

NOTE: COMPRESSED AIR REQUIRED - 375 CFM @ 125 PSI.



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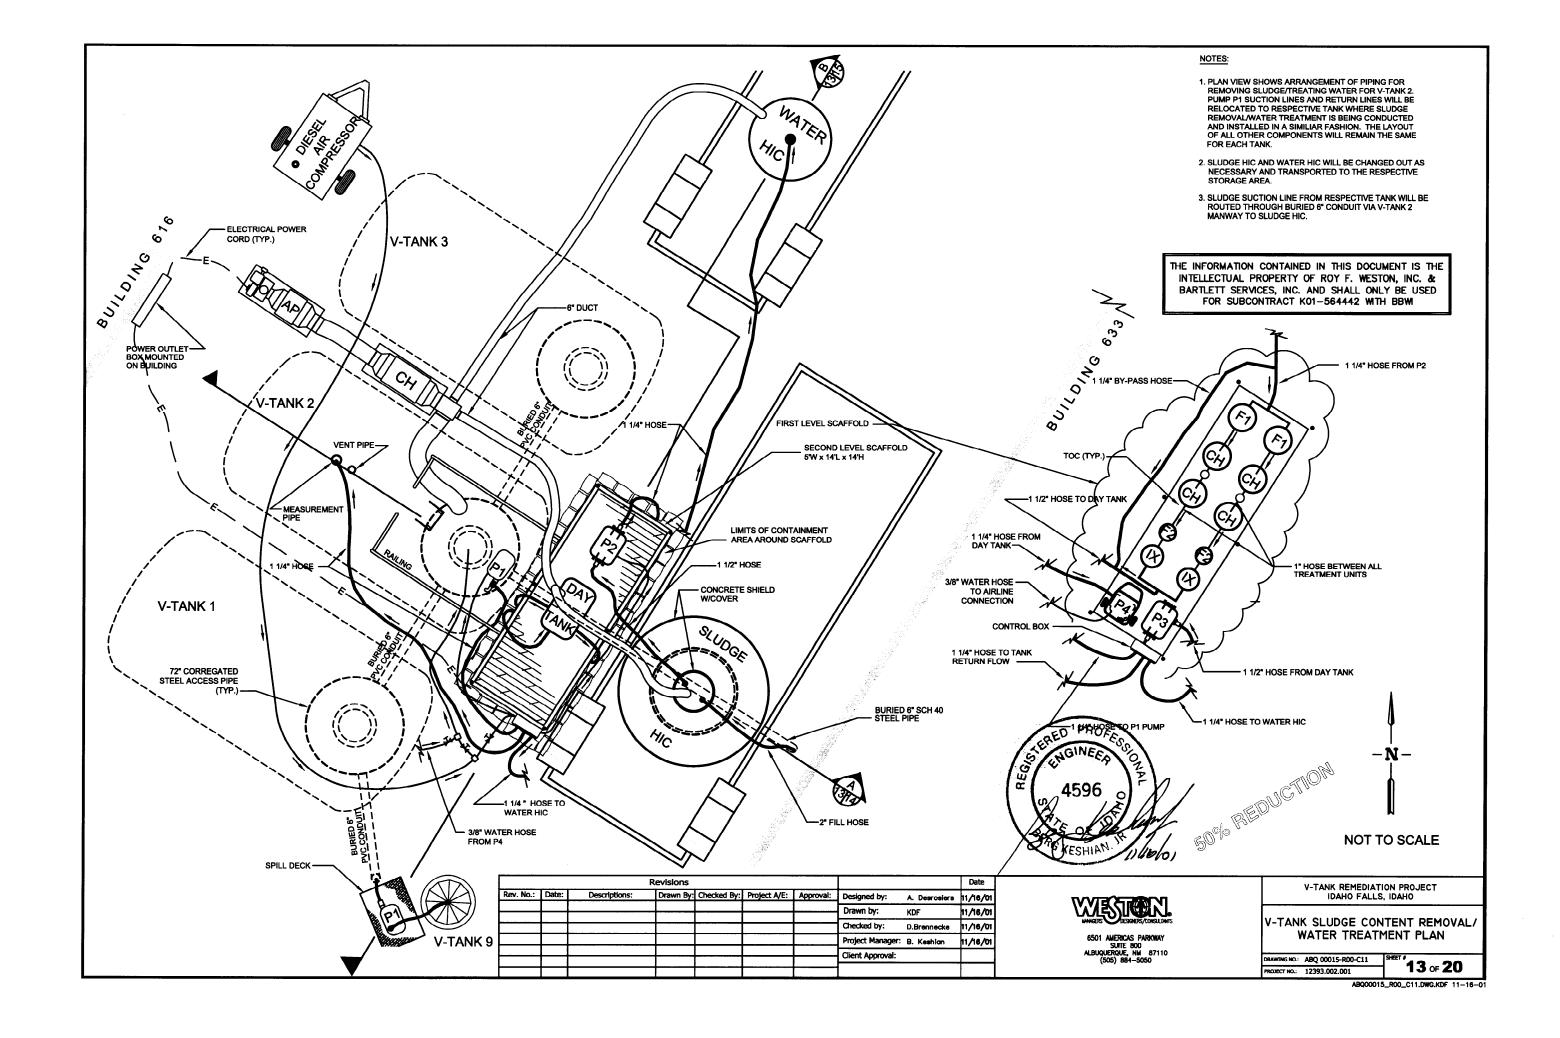
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Rev. No.:	Date:	Descriptions:	Drawn By:	Checked By:	Project A/E:	Approval:	Designed by:	A. Desrosiers	11/16/01
			+ -				Drawn by:	JMM/KDF	11/16/01
							Checked by:	D.Brennecke	11/16/01
							Project Manager:	B. Keshian	11/16/01
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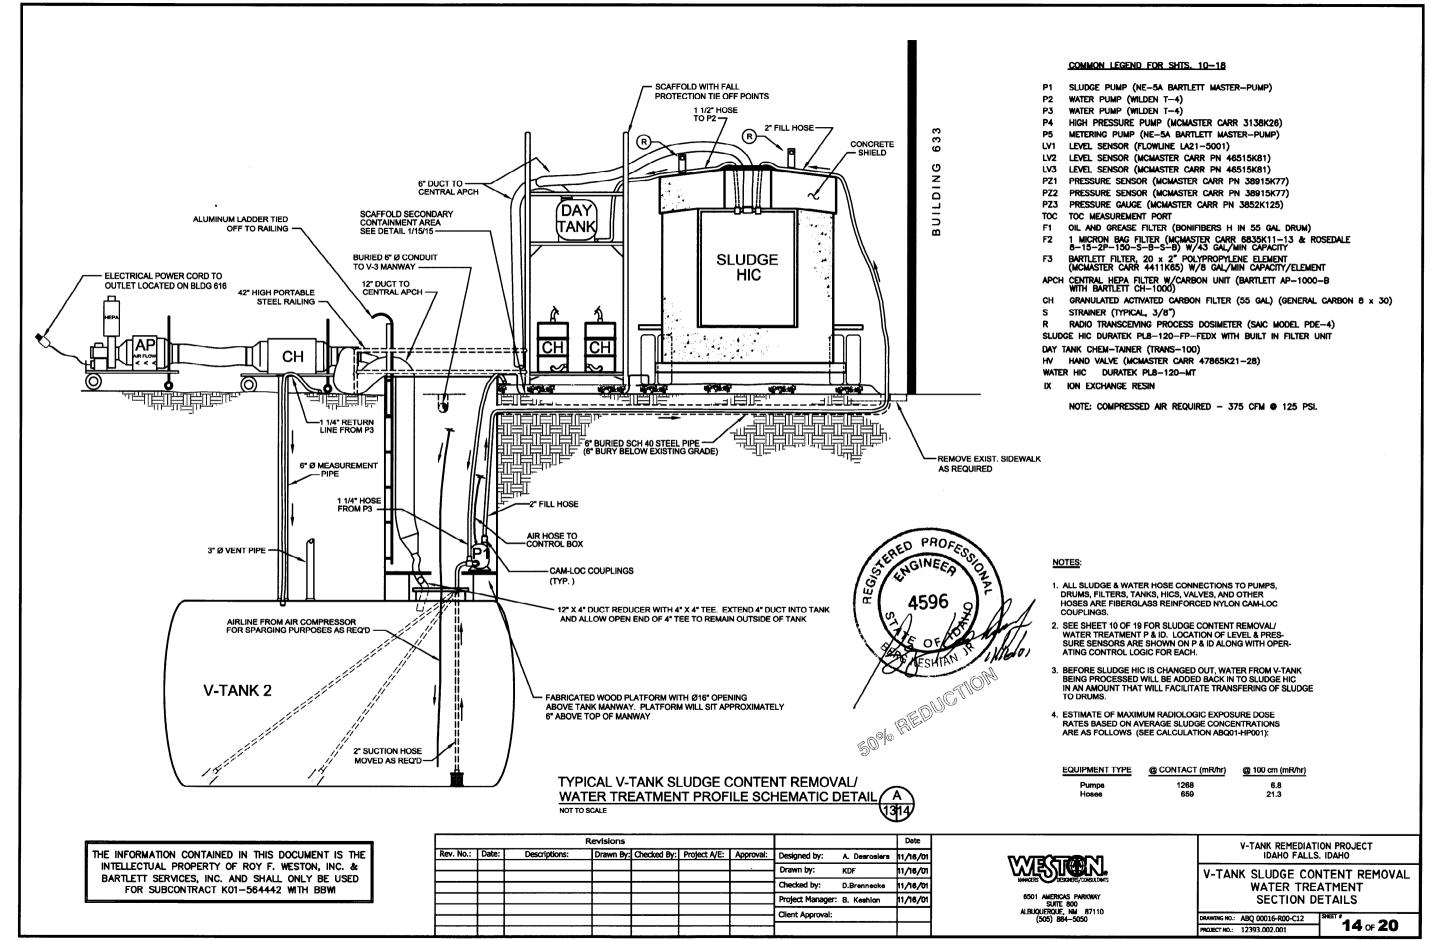
V-TANK REMEDIATION PROJECT IDAHO FALLS, IDAHO


V-TANK DRUM FILLING & **DEWATERING PROCESS AND** INSTRUMENTATION DIAGRAM (P & ID)


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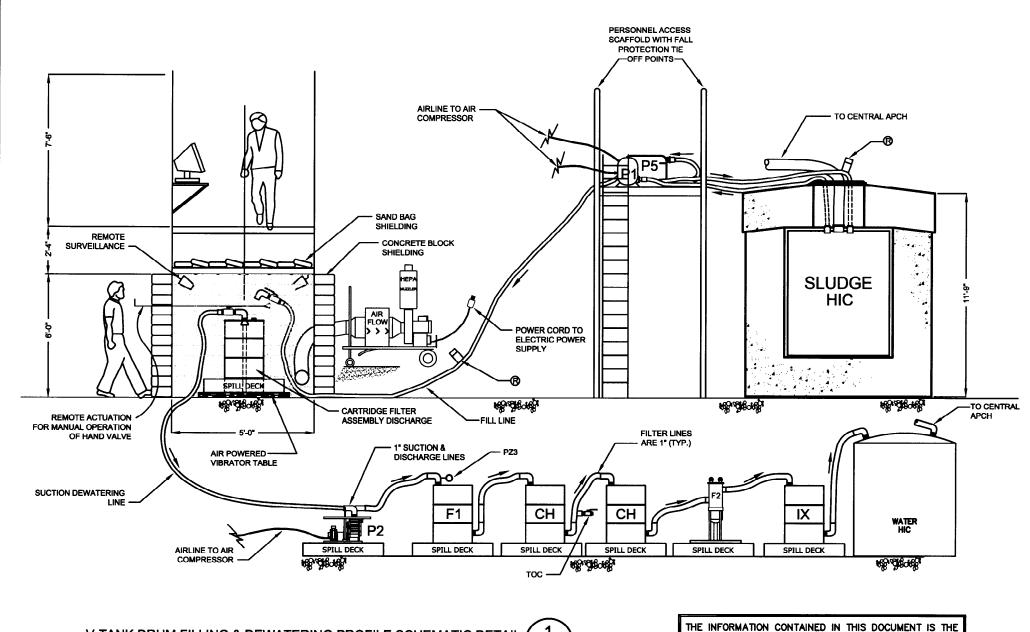
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- 1. SUPER SLEEVER SECONDARY CONTAINMENT USED TO SLEEVE HOSES, VALVES, & FITTINGS.
- 3. SCAFFOLD DECK SANDBAG LOAD CAPACITY: 75 LBS./FT
- 4. ALL SLUDGE LINES AND WATER HOSE CONNECTIONS TO PUMPS, DRUMS, FILTERS, TANKS, HICS, VALVES, AND OTHER HOSES ARE FIBERGLASS REINFORCED NYLON CAM-LOC COUPLINGS.
- 5. CONTENTS OF WATER HIC WILL BE TREATED AS REQUIRED.
- 6. SLUDGE LINES AND WATER LINES WILL BE PURGED WITH AIR PRIOR TO CHANGING FILTERS OR DISCONNECTING HOSES.
- 7. SEE SHEET 12 OF 19 FOR DRUM FILLING & DEWATERING P & ID.
- 8. ESTIMATE OF MAXIMUM RADIOLOGIC EXPOSURE DOSE RATES BASED ON AVERAGE SLUDGE CONCENTRATIONS ARE AS FOLLOWS: (SEE CALCULATION ABQ01-HP001):

EQUIPMENT TYPE	@ CONTACT (mR/hr)	@ 100 CM (mR/hr)
PUMPS	1268	6.8
HOSES	659	21.3
DRUMS	7398	193

#### COMMON LEGEND FOR SHTS. 10 - 18

- SLUDGE PUMP (NE-5A BARTLETT MASTER-PUMP)
- WATER PUMP (WILDEN T-4)
- WATER PUMP (WILDEN T-4)
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- METERING PUMP (NE-5A BARTLETT MASTER-PUMP)
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- LEVEL SENSOR (MCMASTER CARR PN 46515K81) LV2
- LEVEL SENSOR (MCMASTER CARR PN 46515K81)
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- IX ION EXCHANGE RESIN

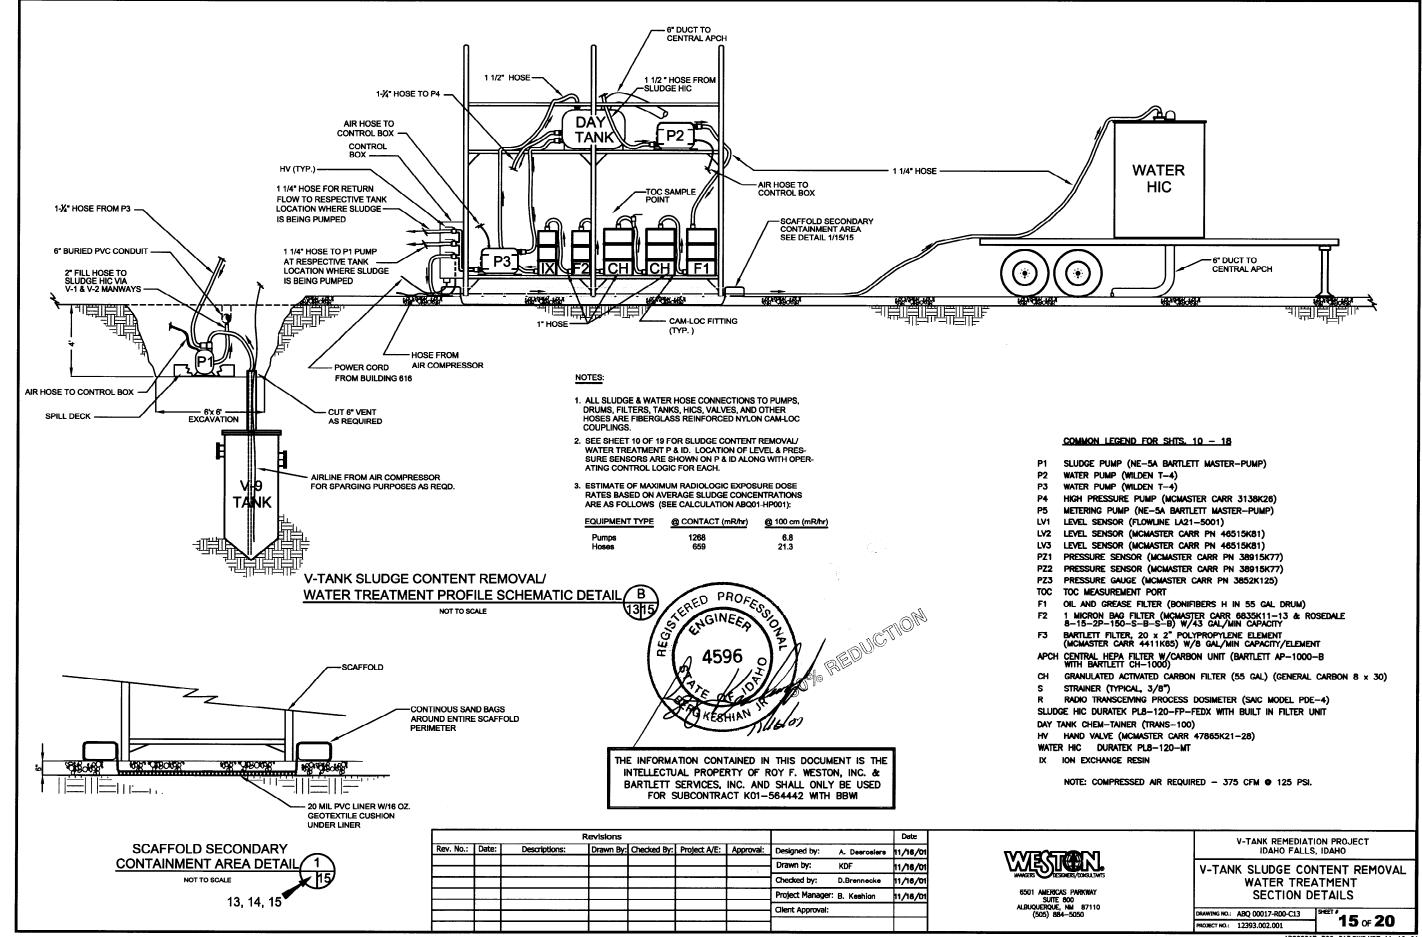NOTE: COMPRESSED AIR REQUIRED - 375 CFM • 125 PSI.

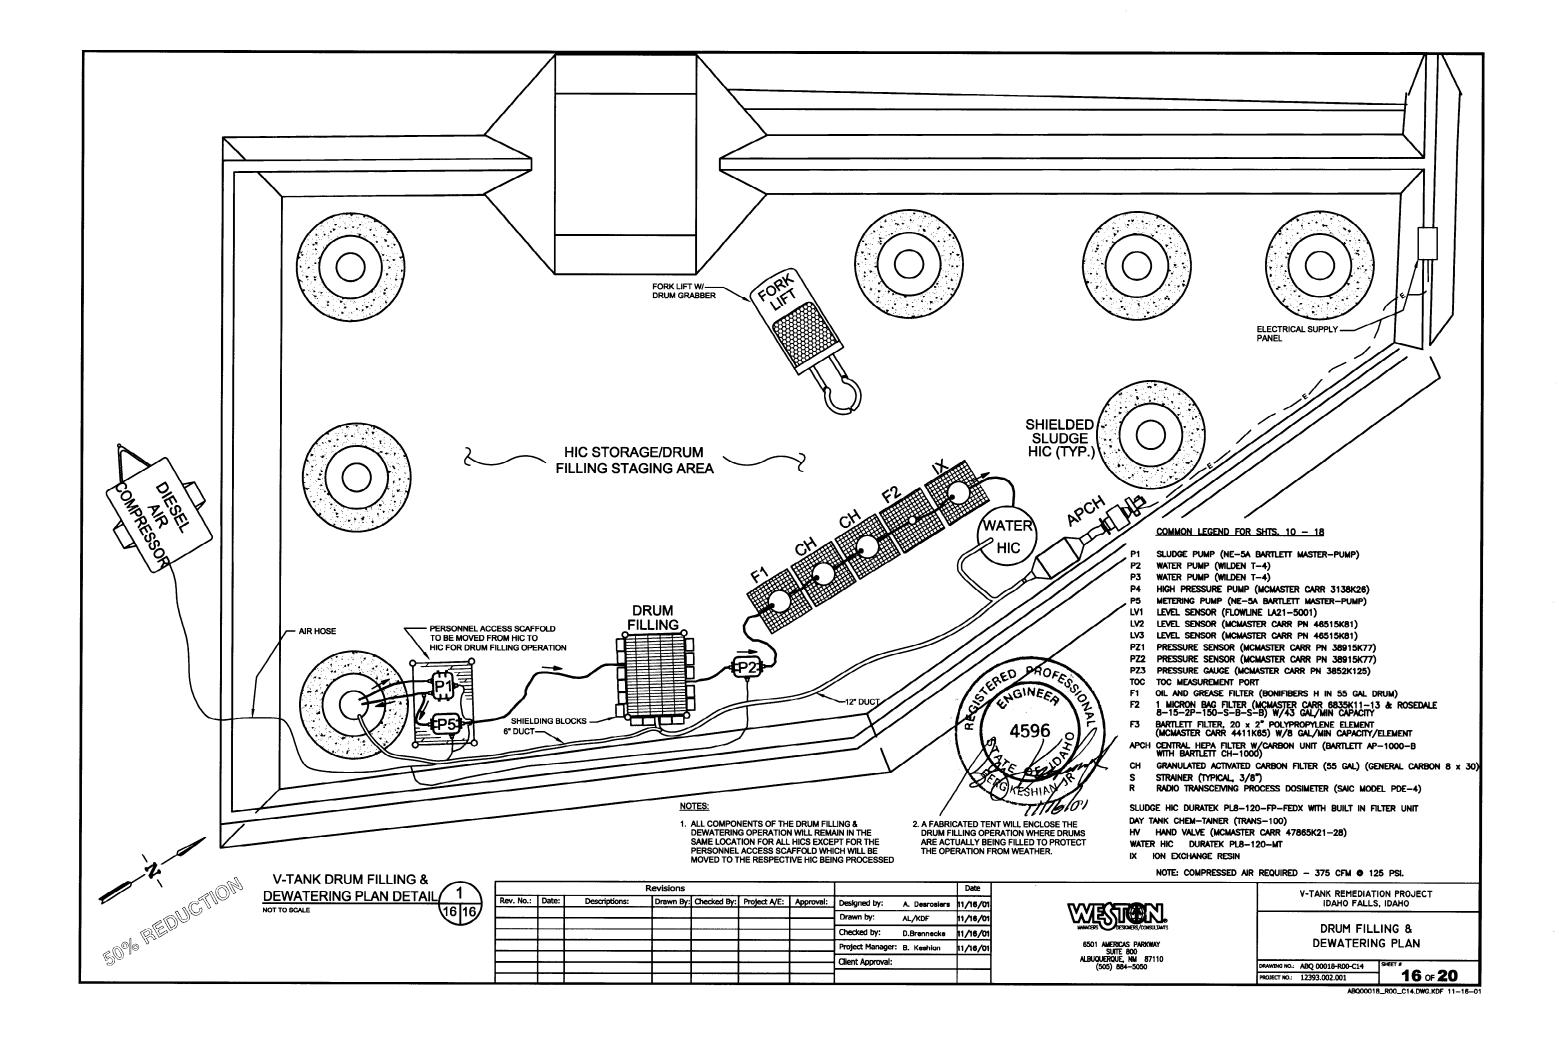Revisions Rev. No.: Date: Descriptions: Drawn By: Checked By: Project A/E: Approval: R. Ederer 11/16/0 Drawn by: JMM/KDF 11/16/01 Checked by: D.Brennecke 11/16/01 Project Manager: B. Keshion 11/16/01 Client Approval:

V-TANK DRUM FILLING & DEWATERING PROFILE SCHEMATIC DETAIL

ERED PART

CHGINEED



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BARTLETT SERVICES, INC. AND SHALL ONLY BE USED FOR SUBCONTRACT K01-564442 WITH BBWI

V-TANK REMEDIATION PROJECT IDAHO FALLS, IDAHO

DRUM FILLING & **DEWATERING SECTION DETAILS** 

DRAWING NO.: ABQ 00020-R00-C15 PROJECT NO.: 12393,002,001

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